


0 KEY PLAN
1" = 50'-0"

- FRAMING PLAN NOTES:**
1. VERIFY DIMS. WITH ARCH. DWGS.
 2. SEE ARCH. DWGS. FOR STEEL THAT REQUIRES FIREPROOFING.
 3. ALL EXISTING DIMENSIONS SHALL BE FIELD VERIFIED.
 4. REFER TO MECHANICAL, ELECTRICAL, AND PLUMBING DRAWINGS TO COORDINATE OPENINGS.
 5. *ML* INDICATES MASONRY LINTEL. SEE SCHEDULE FOR REINF.


R1 DENOTES SPAN OF 2" DOVETAIL METAL ROOF DECK. SEE GENERAL NOTES FOR ADDITIONAL DETAILS.

S1 DENOTES SPAN OF 6" COMPOSITE SLAB. SLAB SHALL BE 3" N.W.C. OVER 2" COMPOSITE METAL DECK. SEE GENERAL NOTES FOR ADDITIONAL DETAILS.

WALL LINTEL SCHEDULE			
LINTEL TAG	WALL THICKNESS	DIMENSIONS	REINFORCING STEEL
ML1	SEE PLAN	16" DEEP CMU BOND BEAM GROUTED SOLID	2#5 BOTTOM

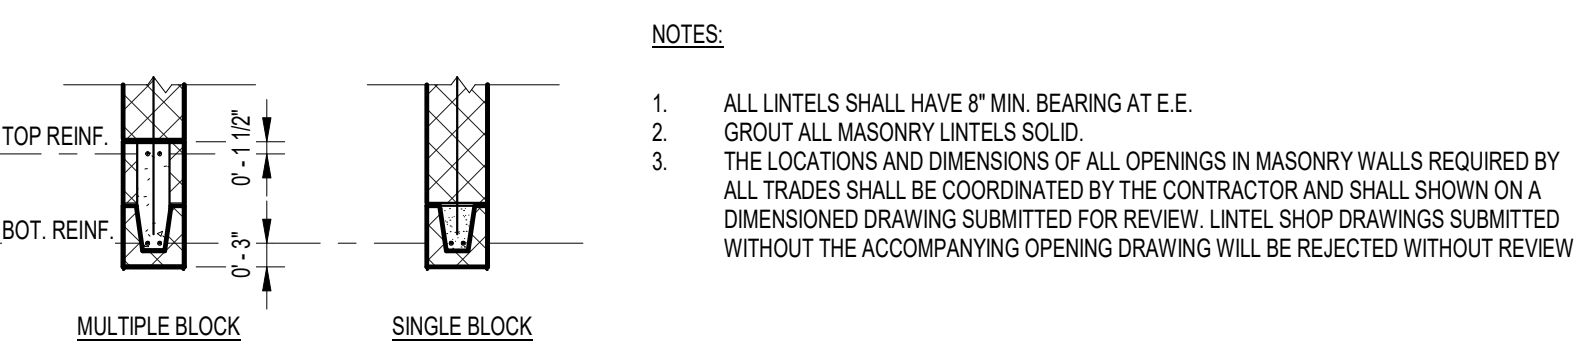


3 MASONRY WALL LINTEL SCHEDULE
1/2" = 1'-0"

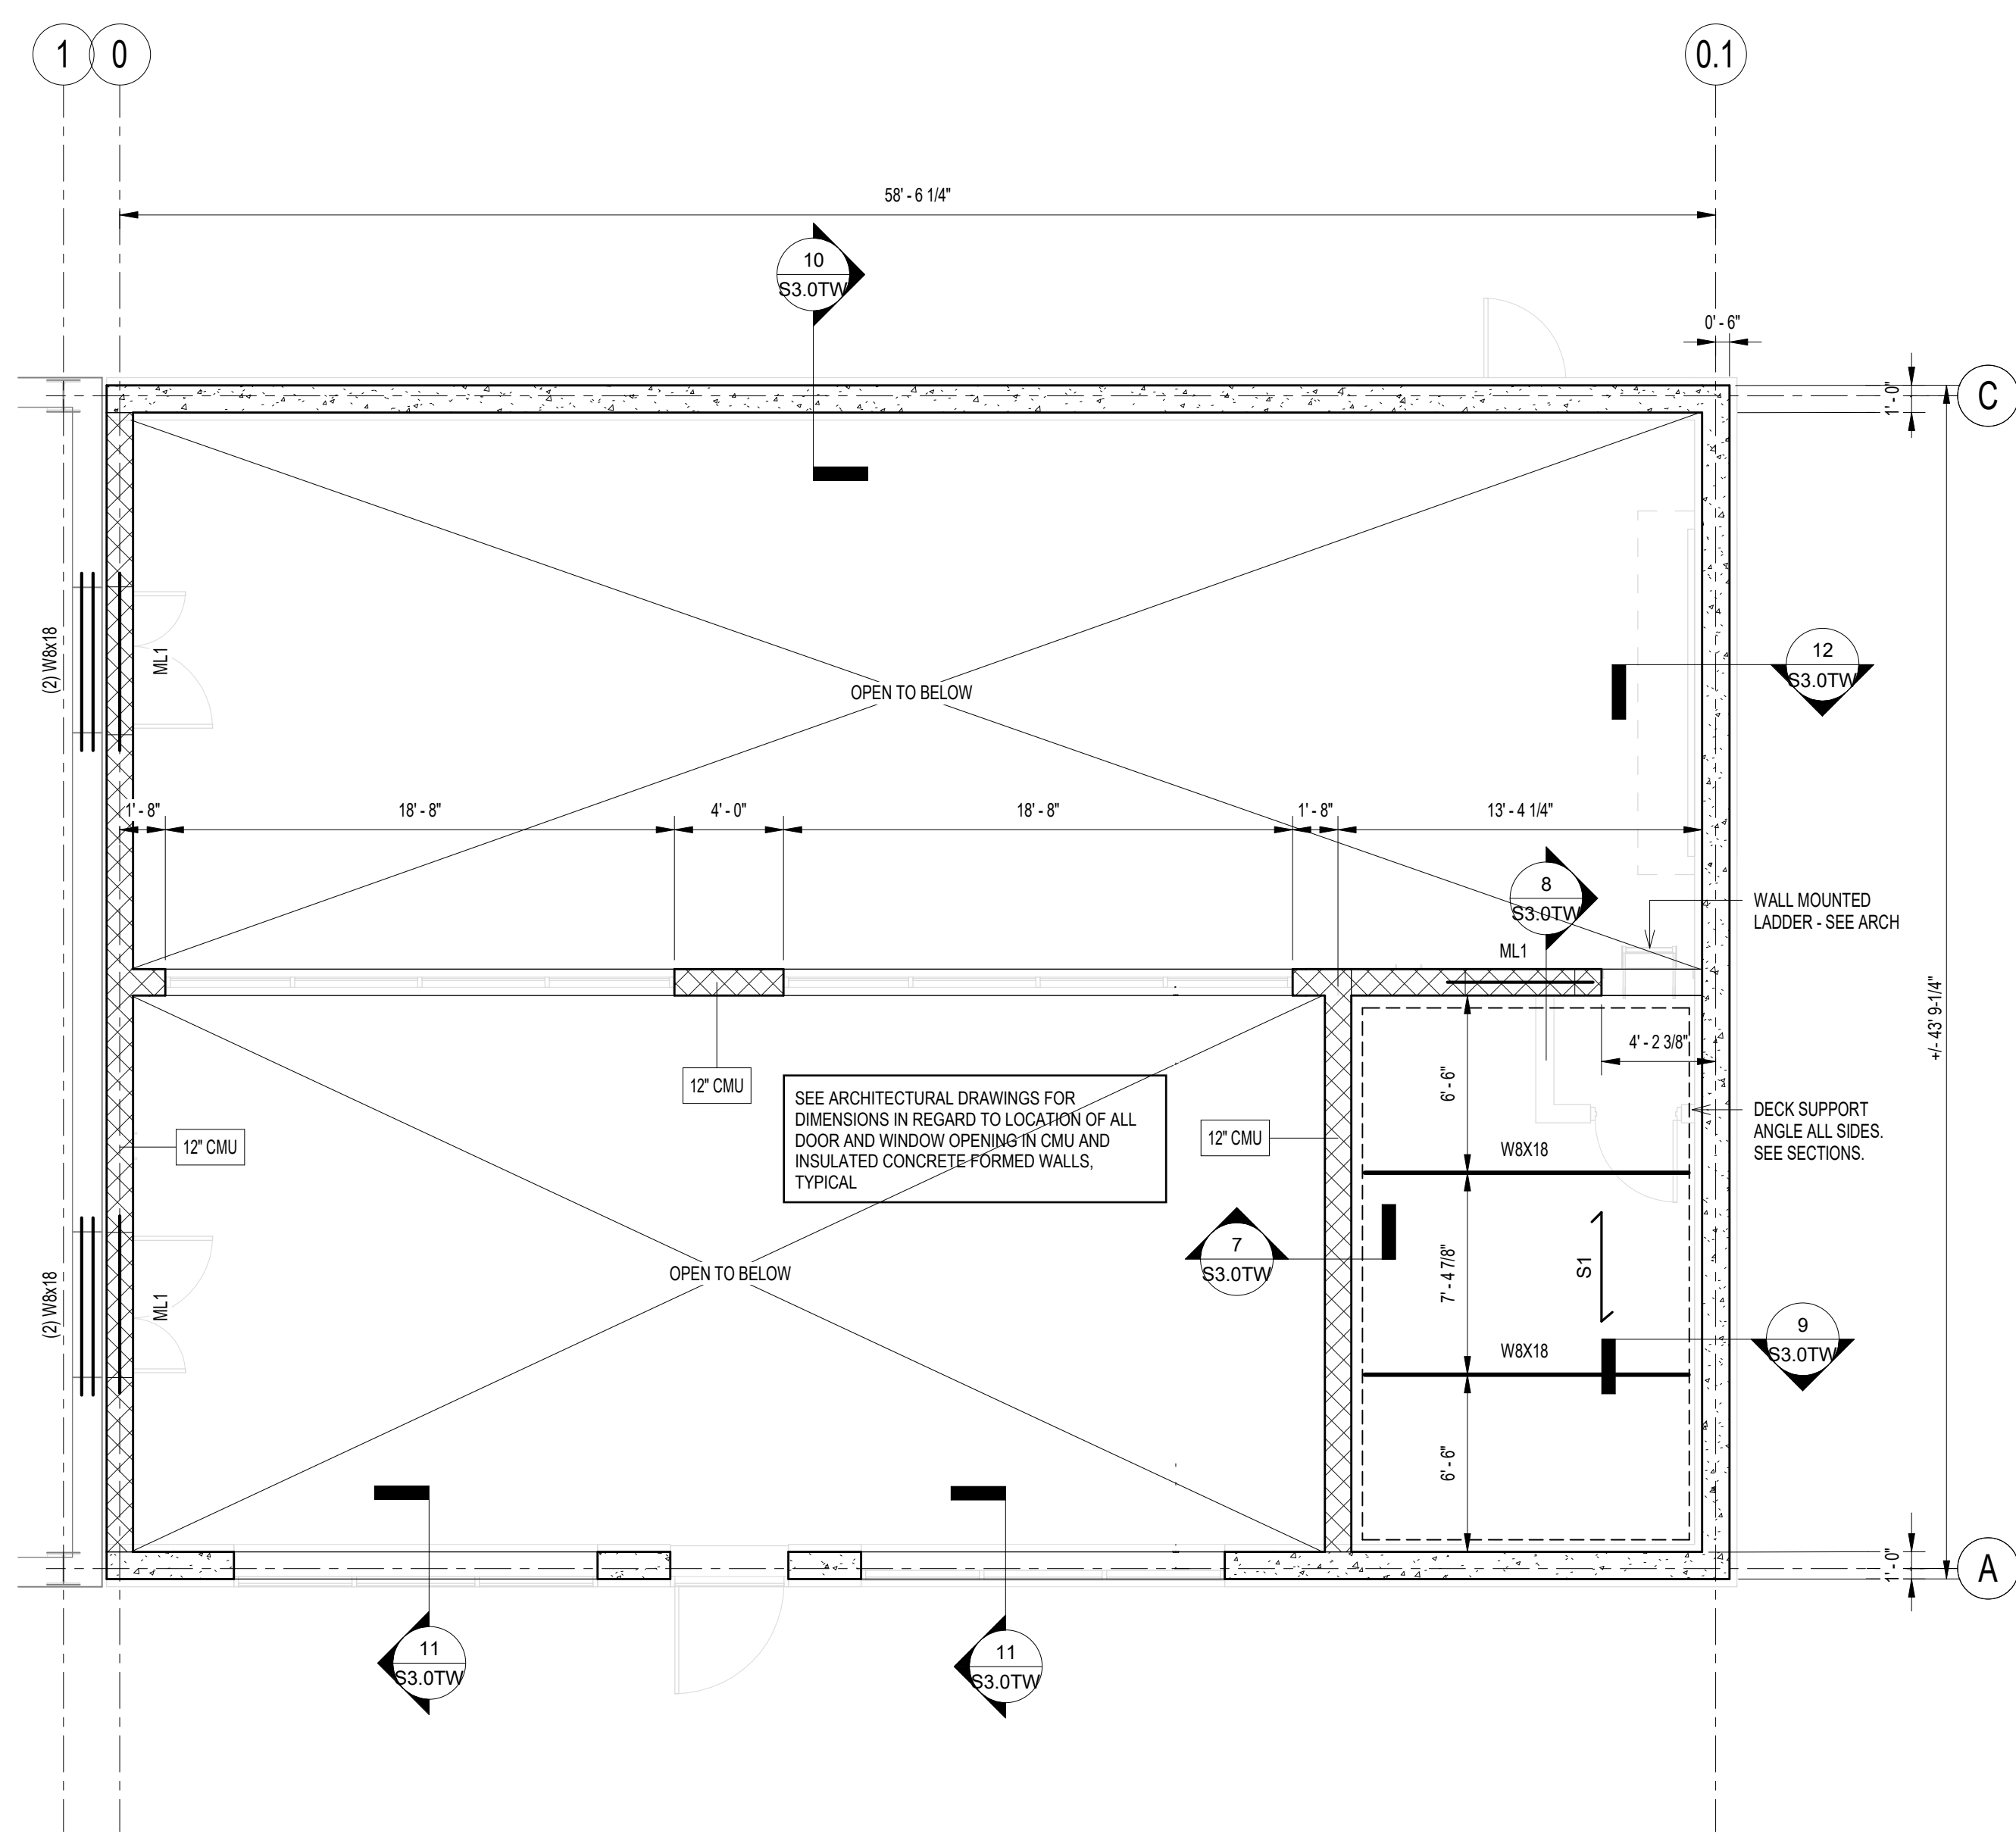

2 MEZZANINE FLOOR PLAN
3/16" = 1'-0"

- FOUNDATION PLAN NOTES:**
1. DATUM ELEVATION 0'-0" = 475.31'
 2. SEE S0.1 SERIES FOR GENERAL NOTES AND S2.0 SERIES FOR TYPICAL DETAILS.
 3. [X-XX] INDICATES TOP OF FOOTING ELEVATION. TOP OF ALL INTERIOR FOOTING ELEV. = 0'-0" U.N.O. TOP OF ALL EXTERIOR FOOTING ELEV. = 2'-0" U.N.O.
 4. BOTTOMS OF ALL PERIMETER FOOTINGS SHALL BE 3'-0" MIN. BELOW GRADE.
 5. SLAB ON GRADE SHALL BE REINFORCED PER THE GENERAL NOTES. SEE GEOTECHNICAL REPORT FOR FOOTING AND SLAB SUBGRADE REQUIREMENTS.
 6. COORDINATE ALL SLAB ON GRADE RECESSES, CURBS, AND LEDGES WITH THE REQUIREMENTS OF THE ARCH. DWGS.
 7. VERIFY SLAB DIMENSIONS WITH ARCH. DWGS. REFER TO ARCH. DRAWINGS FOR SLAB EDGE DIMENSIONS NOT INDICATED.
 8. FOUNDATIONS, COLUMNS, AND PERS ARE CENTERED ON THE GRID LINES. U.N.O.; ALL BEAMS TO BE EQUALLY SPACED BETWEEN COLUMN LINES. U.N.O.

MARK	DIMENSIONS		CONTINUOUS REINF.	TRANSVERSE REINF.
	WIDTH	DEPTH		
WF20	2'-0"	1'-0"	3-#5	#4 AT 48"
WF26	2'-6"	1'-0"	4-#5	#4 AT 48"

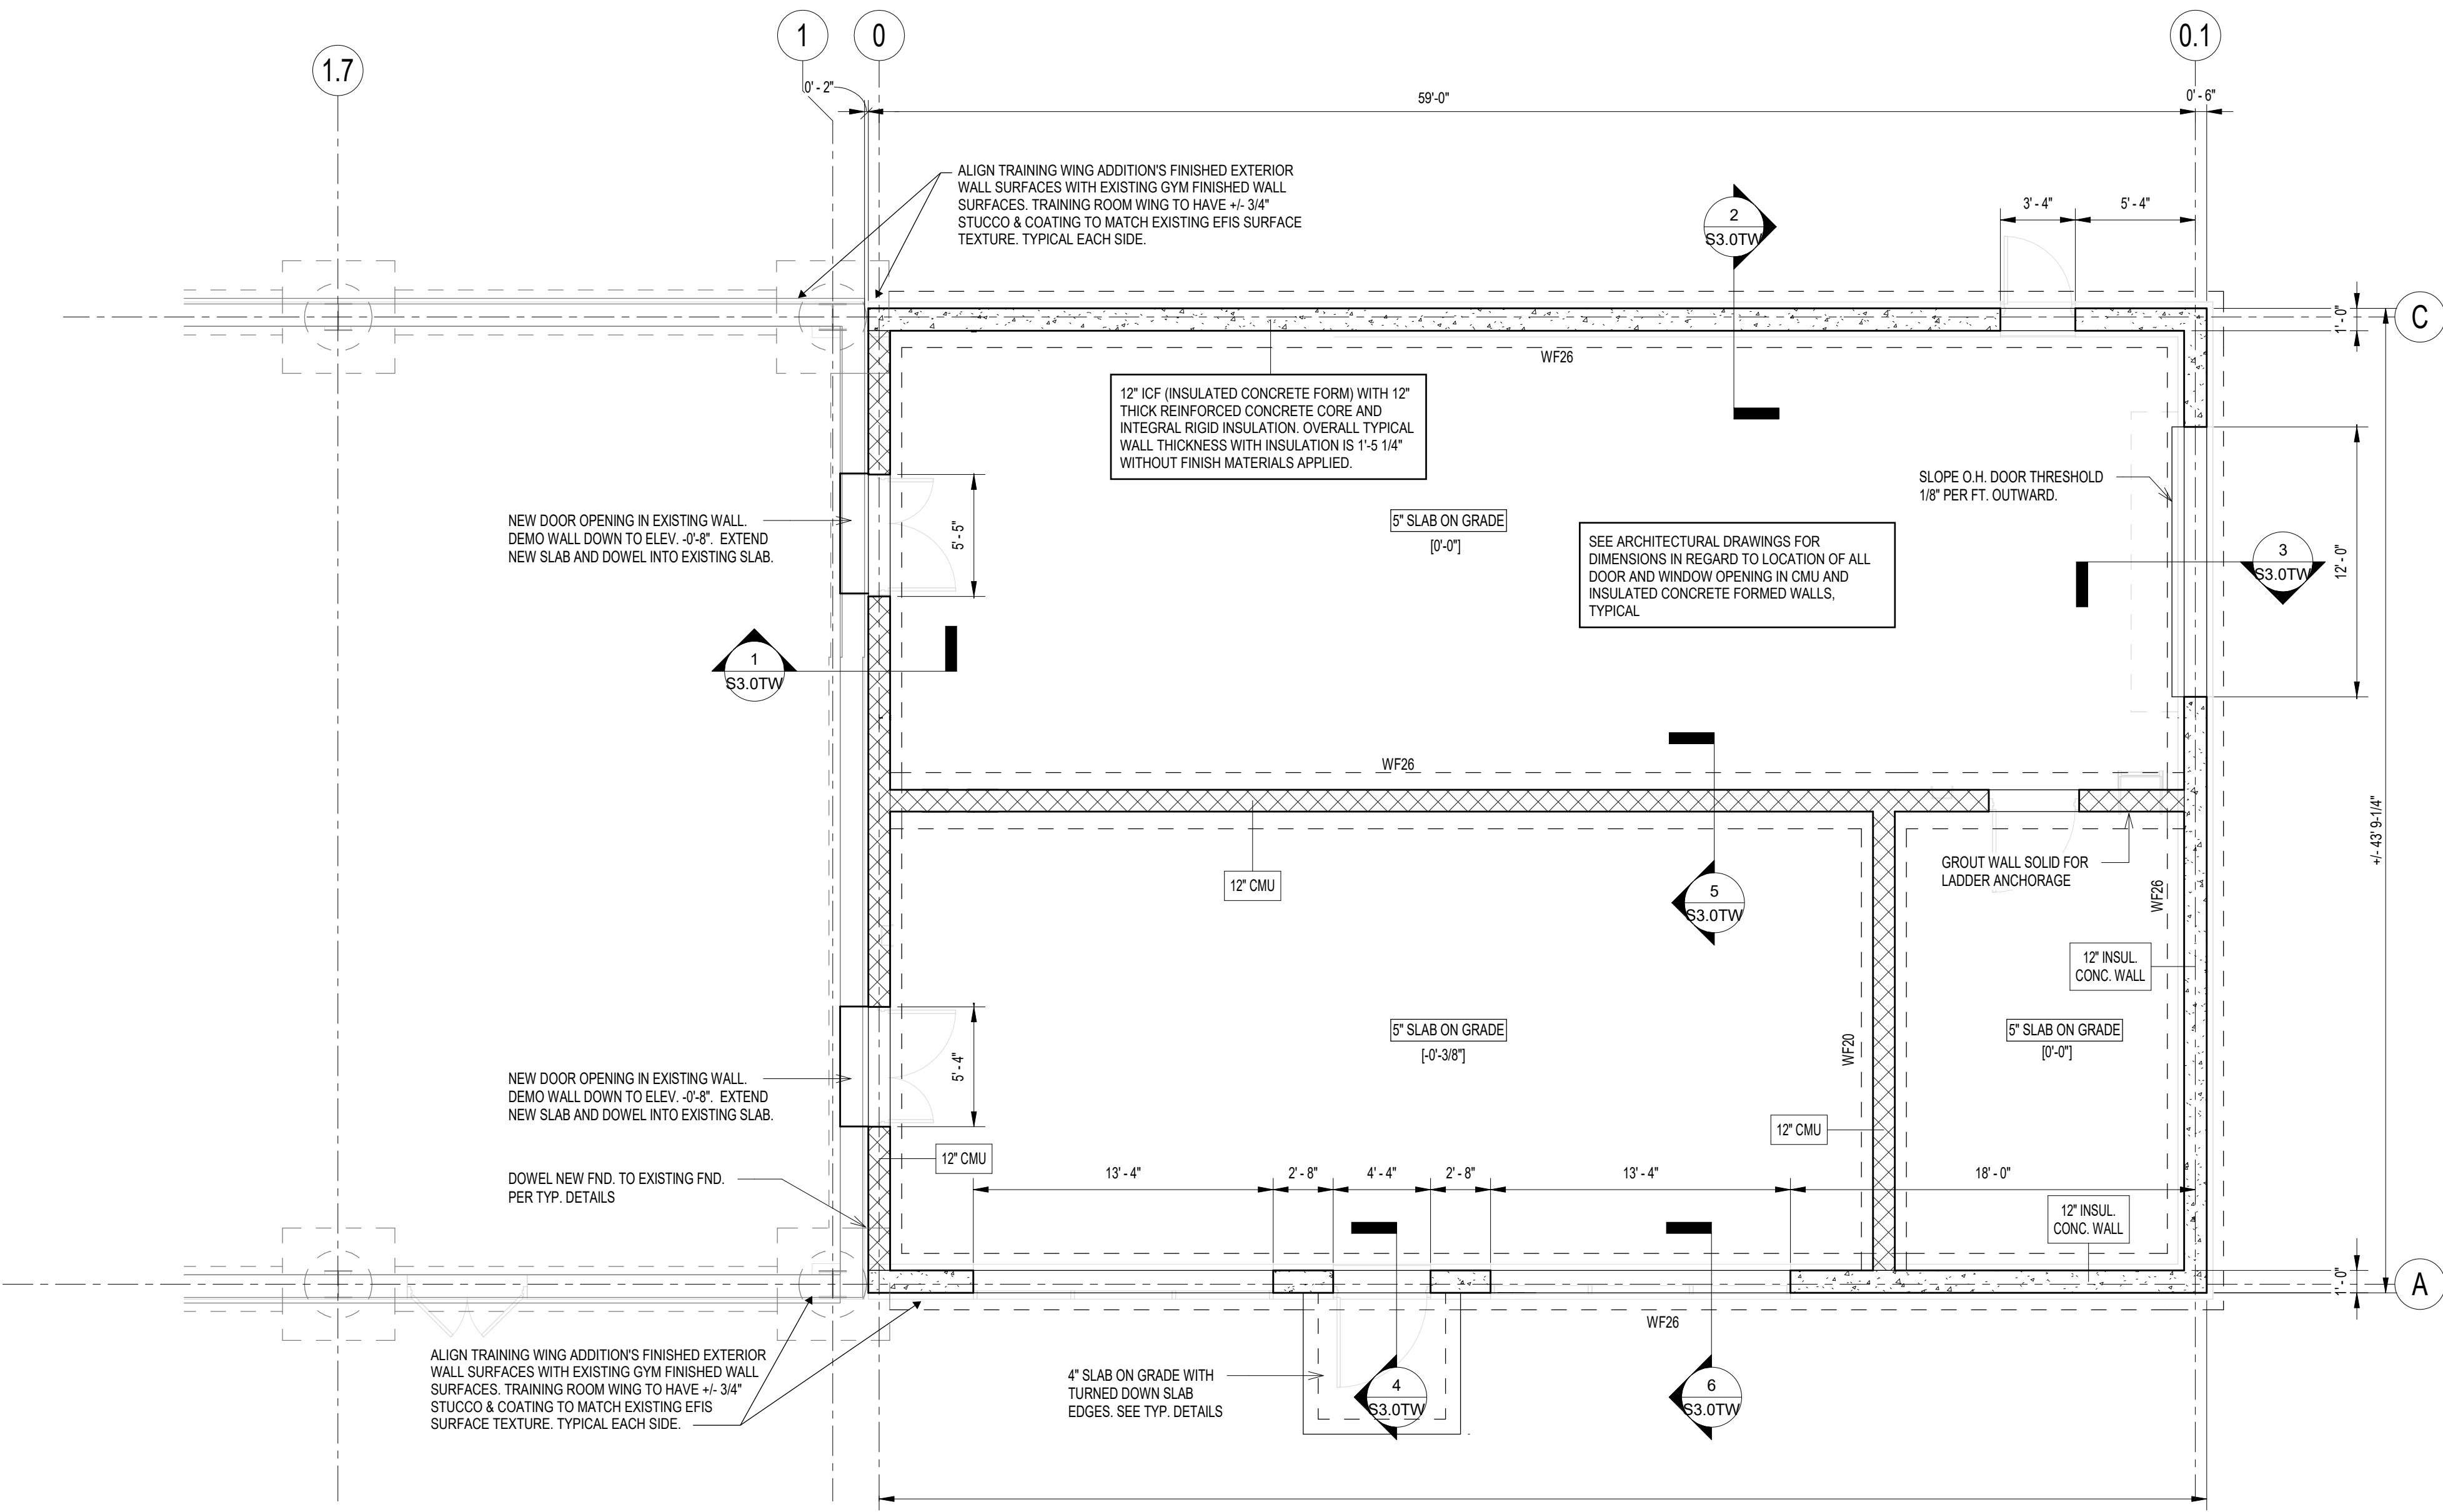

1 FOUNDATION PLAN
3/16" = 1'-0"

ISSUE LOG

Distribution	Date	No.
ISSUE FOR PERMIT	12/16/22	

Client:
PA GAME COMMISSION

TRAINING WING ADDITION

Drawing Title:
FOUNDATION AND MEZZANINE PLANS

Issue Date:
2022-12-16
Project Number: 0336.01
Drawing Number: NB

S1.0TW



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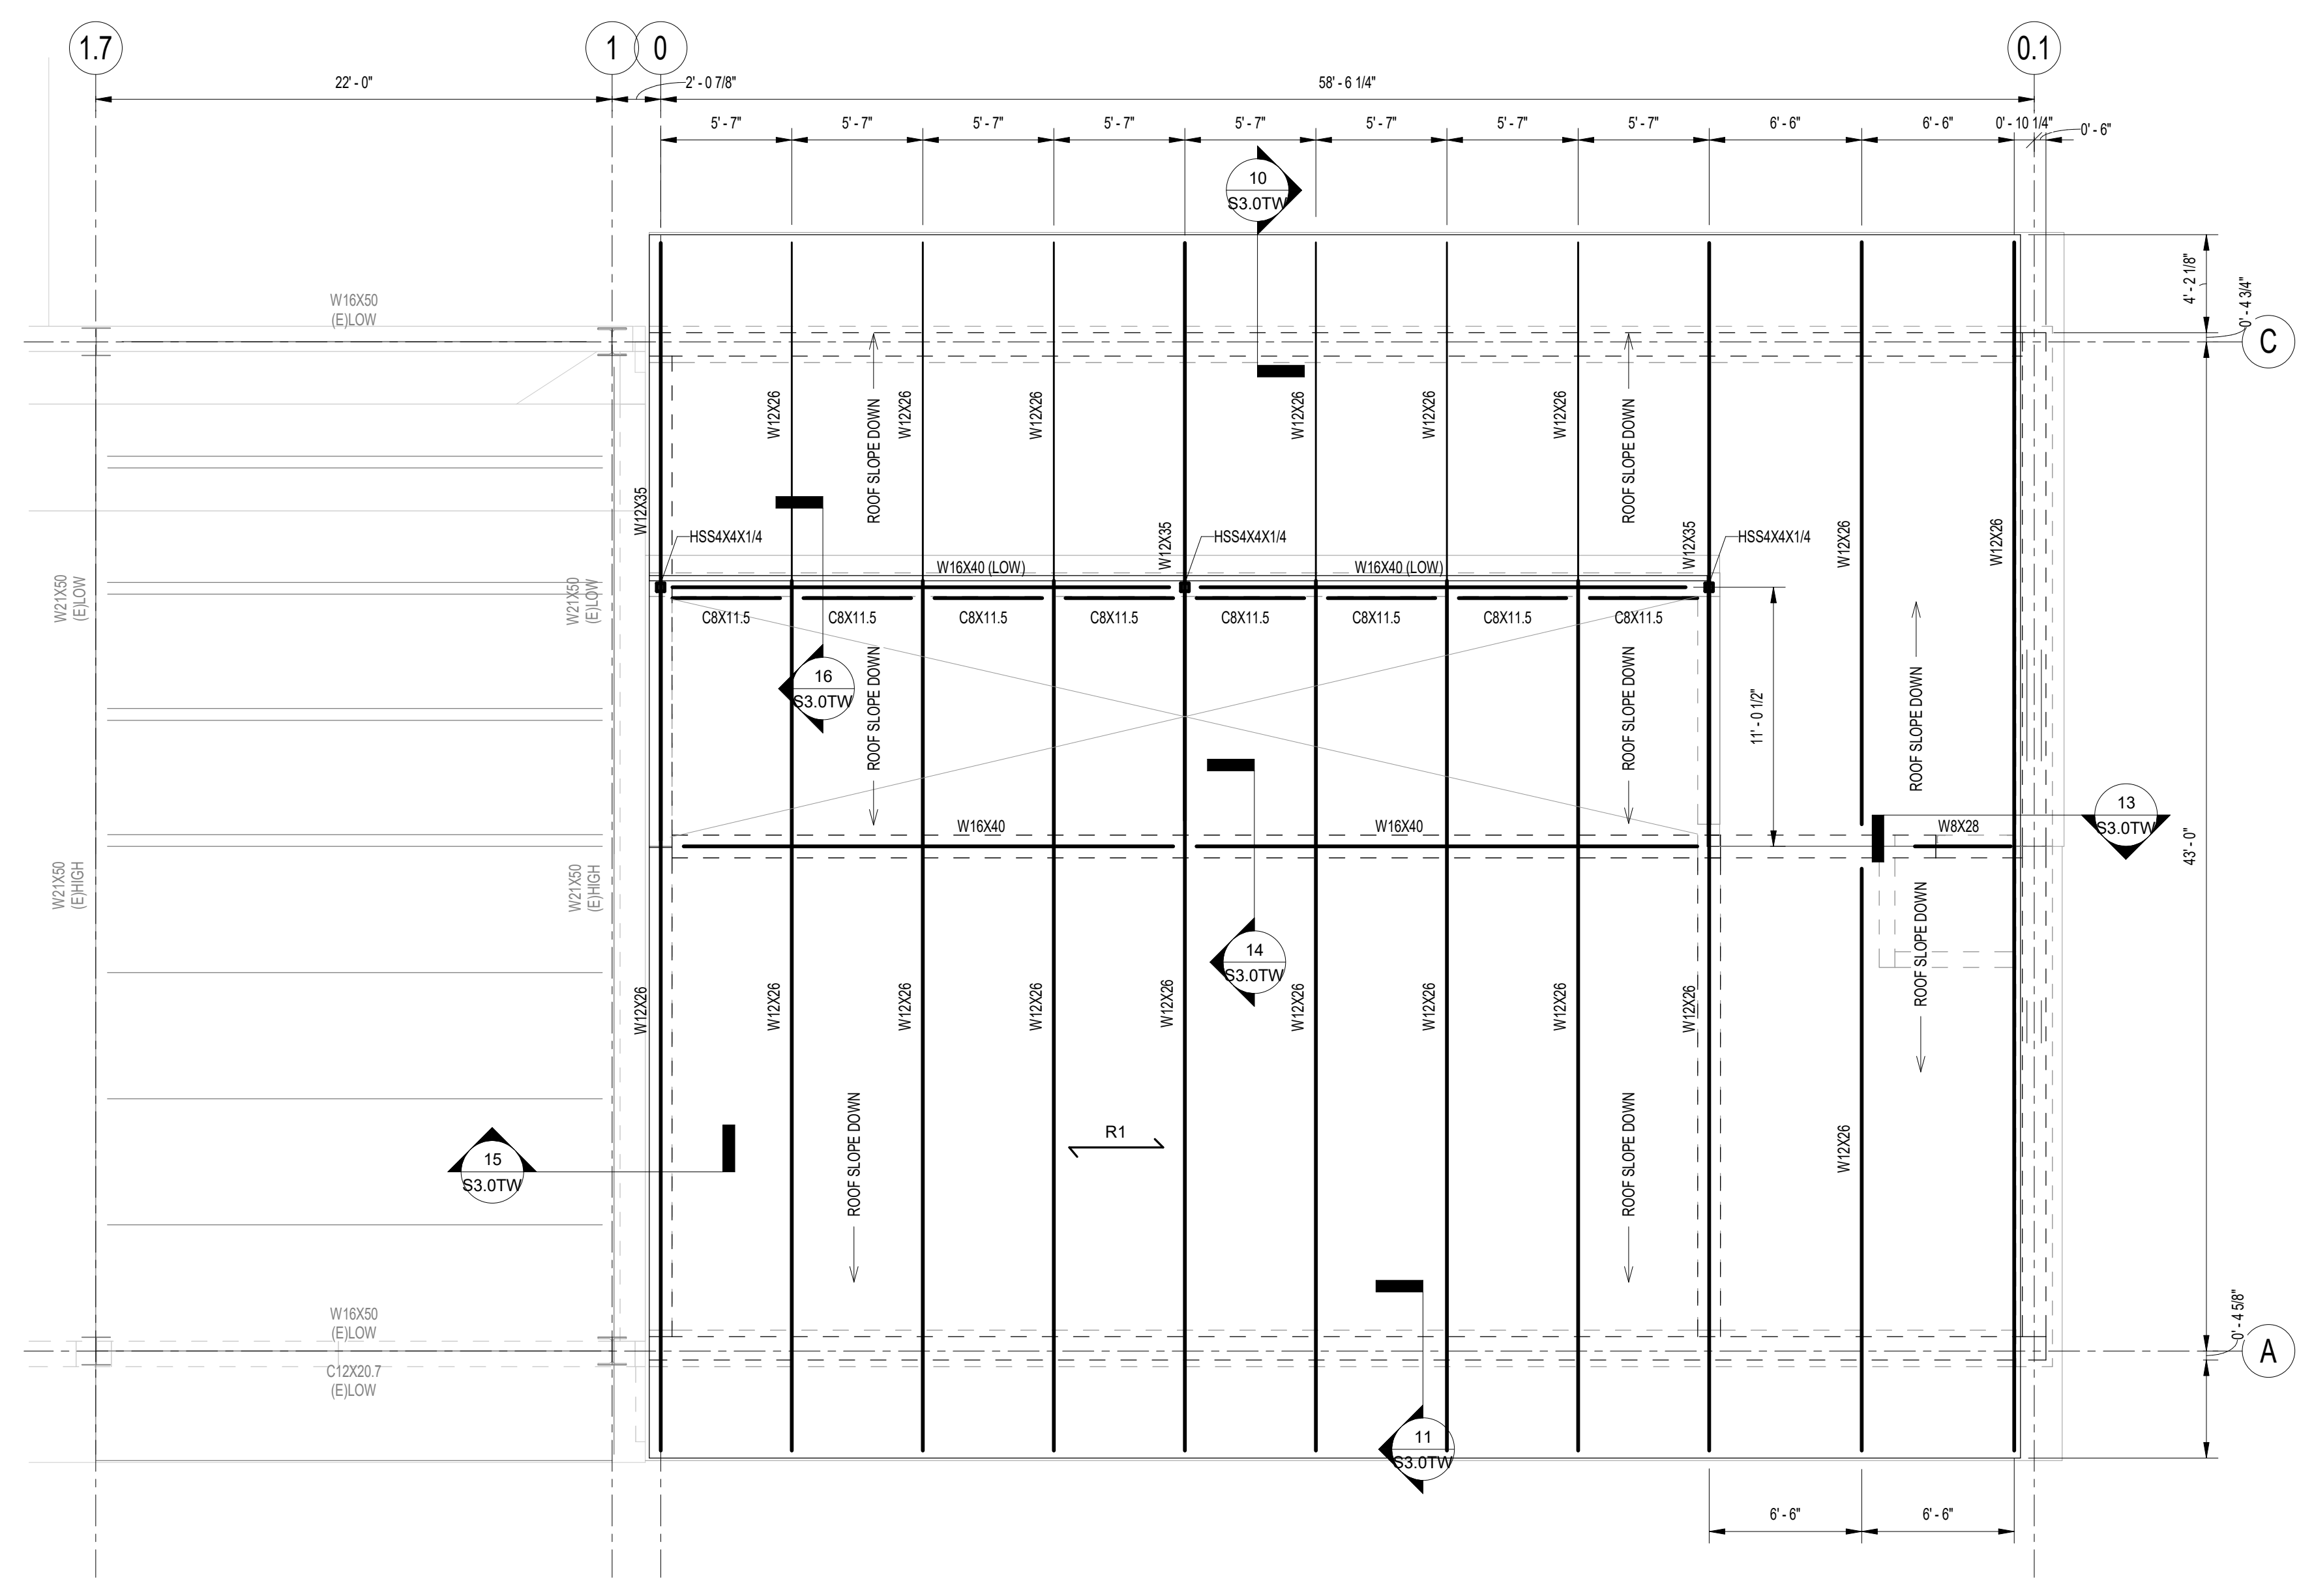
Consultants:
STRUCTURAL: WZG Structural Consulting Engineers, Inc.
 1137 Gravel Pike
 Zieglerville, PA 19492
CIVIL: First Capital Engineering, Inc.
 48 South Richland Avenue
 York, PA 17404
MEP: Schade Engineering, Inc.
 929 Glenbrook Avenue
 Bryn Mawr, PA 19010



FRAMING PLAN NOTES:

1. VERIFY DIMS. WITH ARCHL DWGS.
2. SEE ARCHL DWGS. FOR STEEL THAT REQUIRES FIREPROOFING.
3. ALL EXISTING DIMENSIONS SHALL BE FIELD VERIFIED.
4. REFER TO MECHANICAL, ELECTRICAL, AND PLUMBING DRAWINGS TO COORDINATE OPENINGS.
5. "ML" INDICATES MASONRY LINTEL. SEE SCHEDULE FOR REINF.

← R1 DENOTES SPAN OF 2' DIAPHRAGM METAL ROOF DECK. SEE GENERAL NOTES FOR ADDITIONAL DETAILS.



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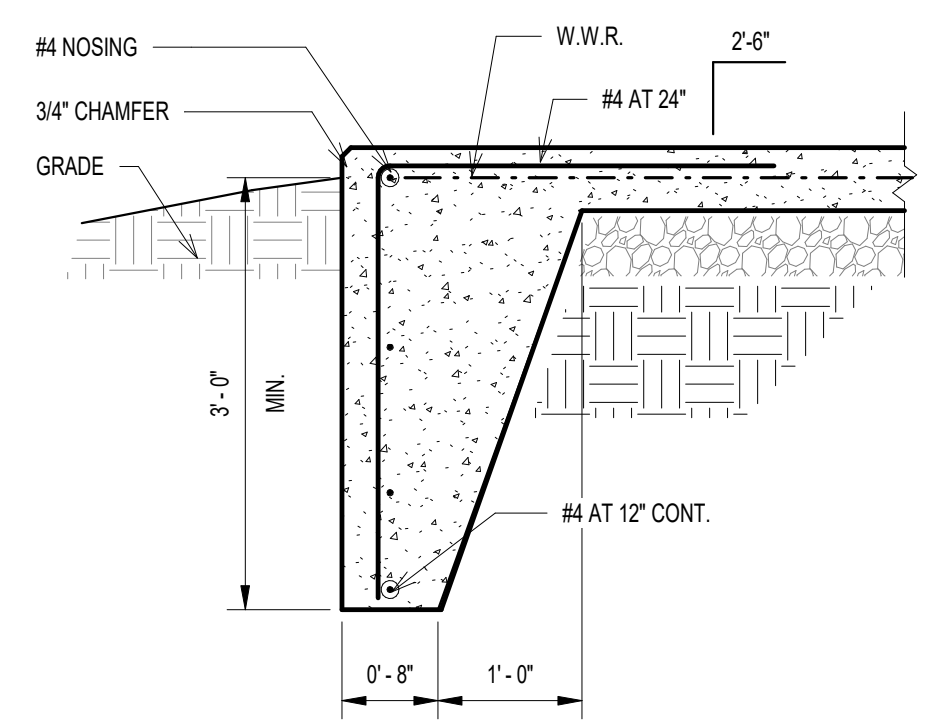
TRAINING WING ADDITION

Drawing Title:
ROOF FRAMING PLAN



Issue Date:
2022-12-16
 Project Number: 0336.01
 Drawing Number: NB

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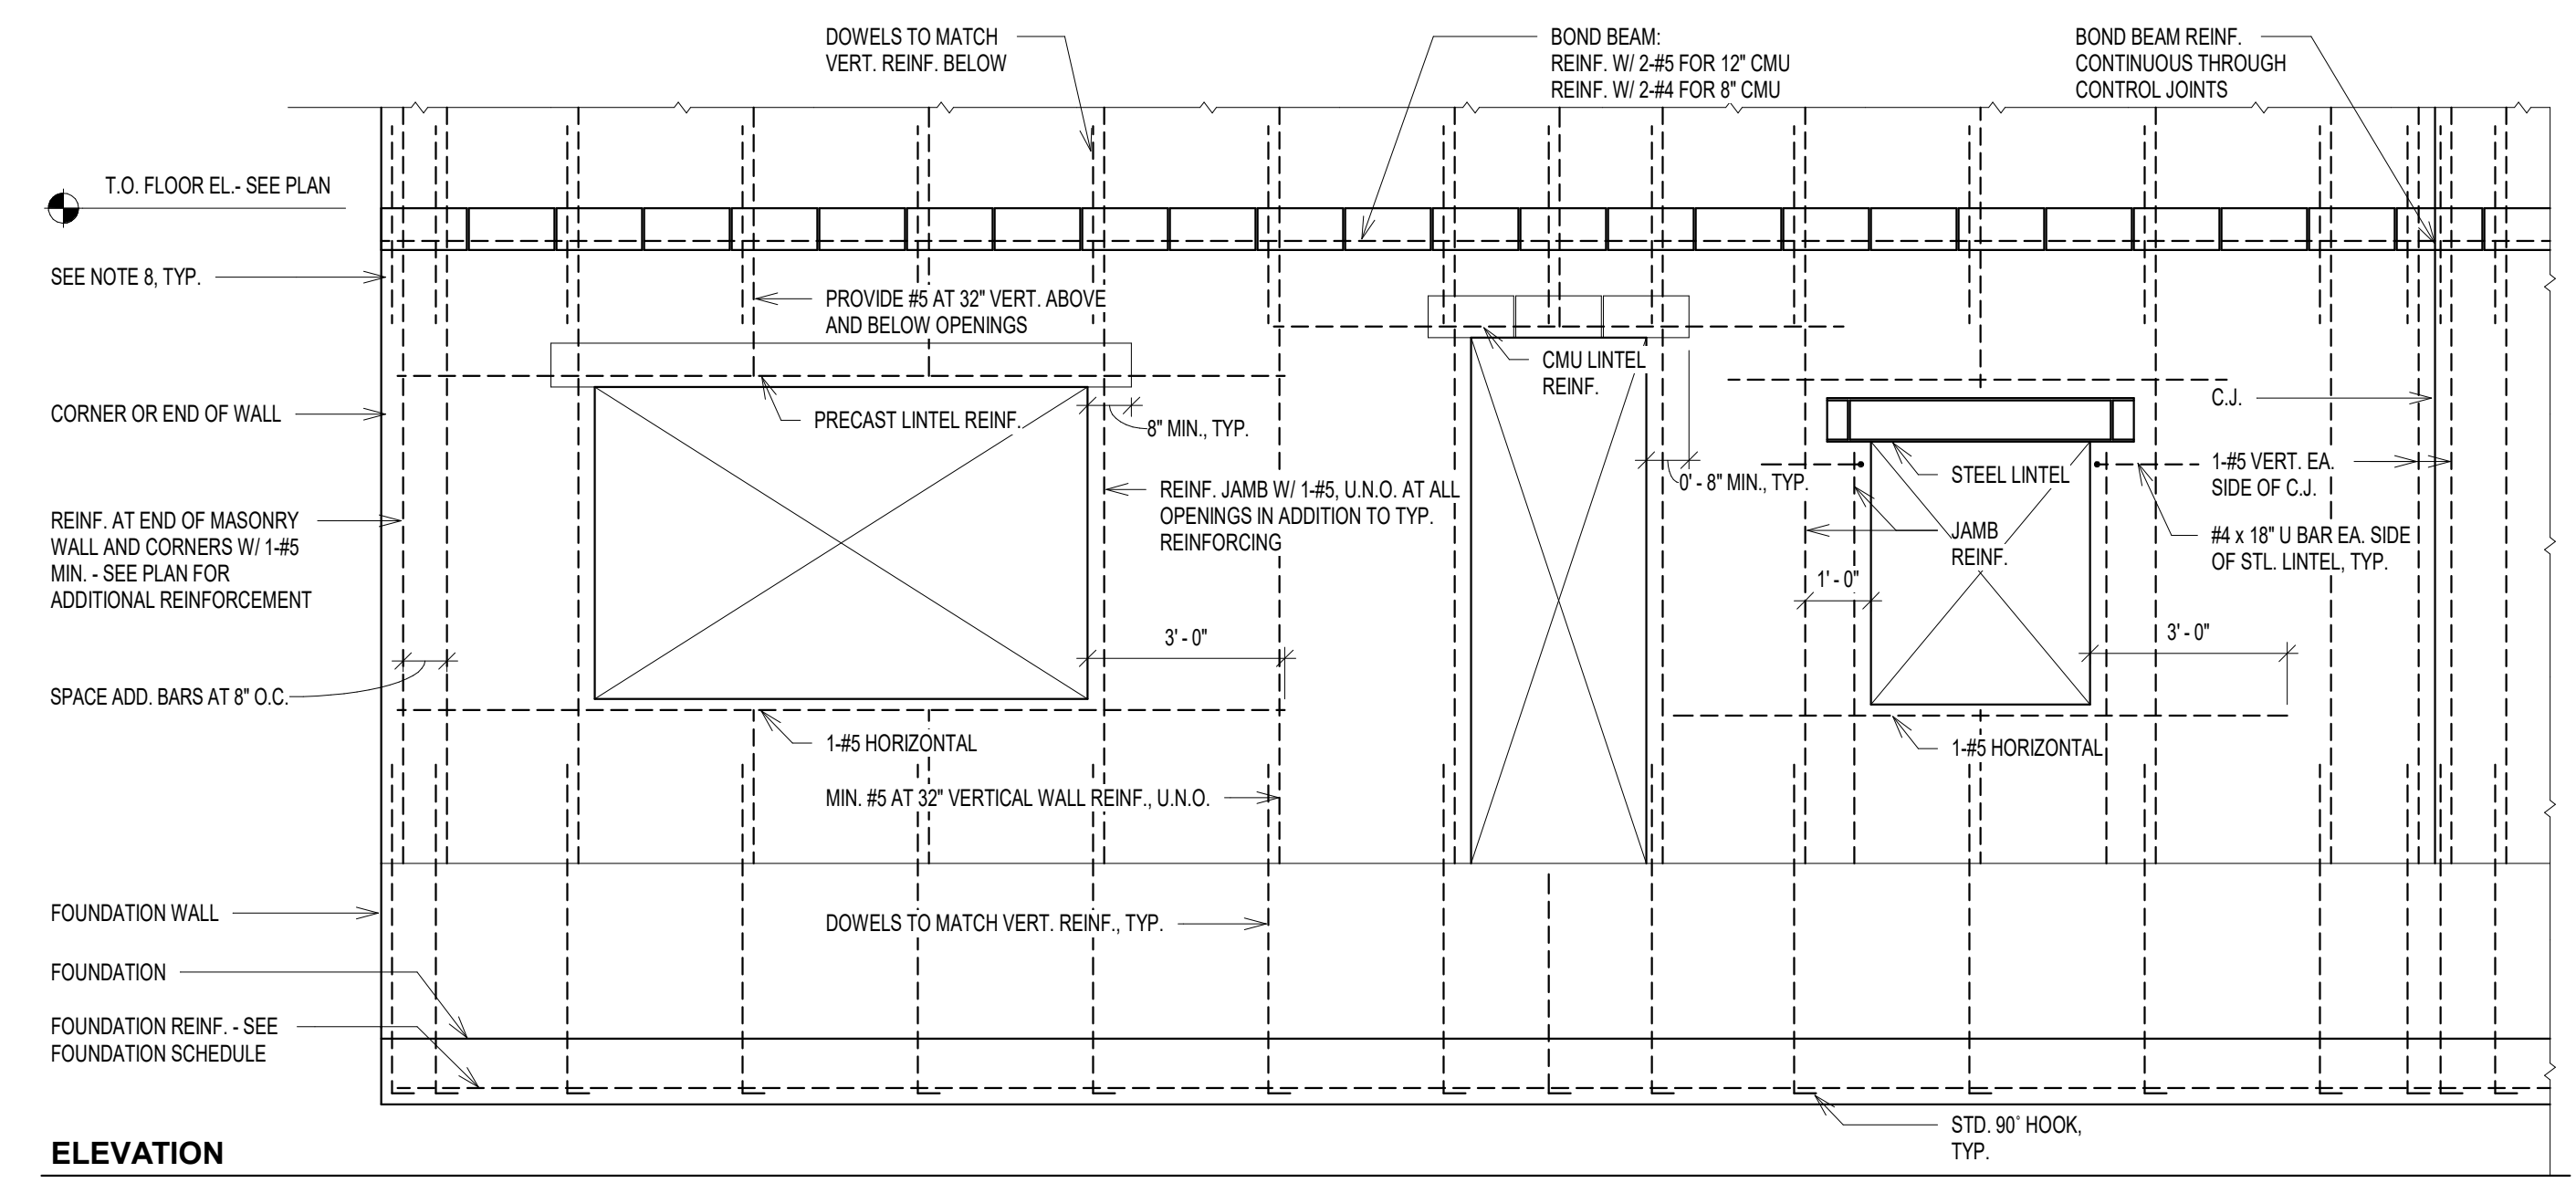
1 ROOF PLAN
3/16" = 1'-0"




9 DOWN-TURNED SLAB DETAIL
3/4" = 1'-0"

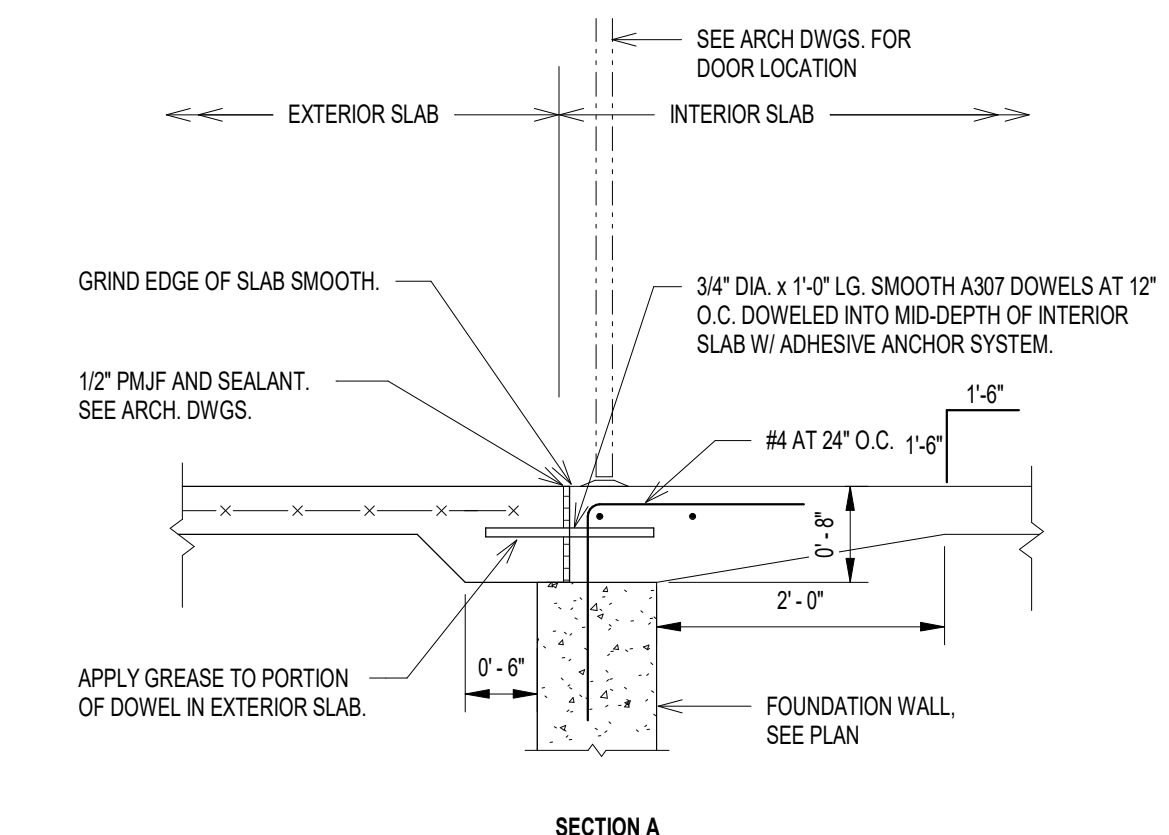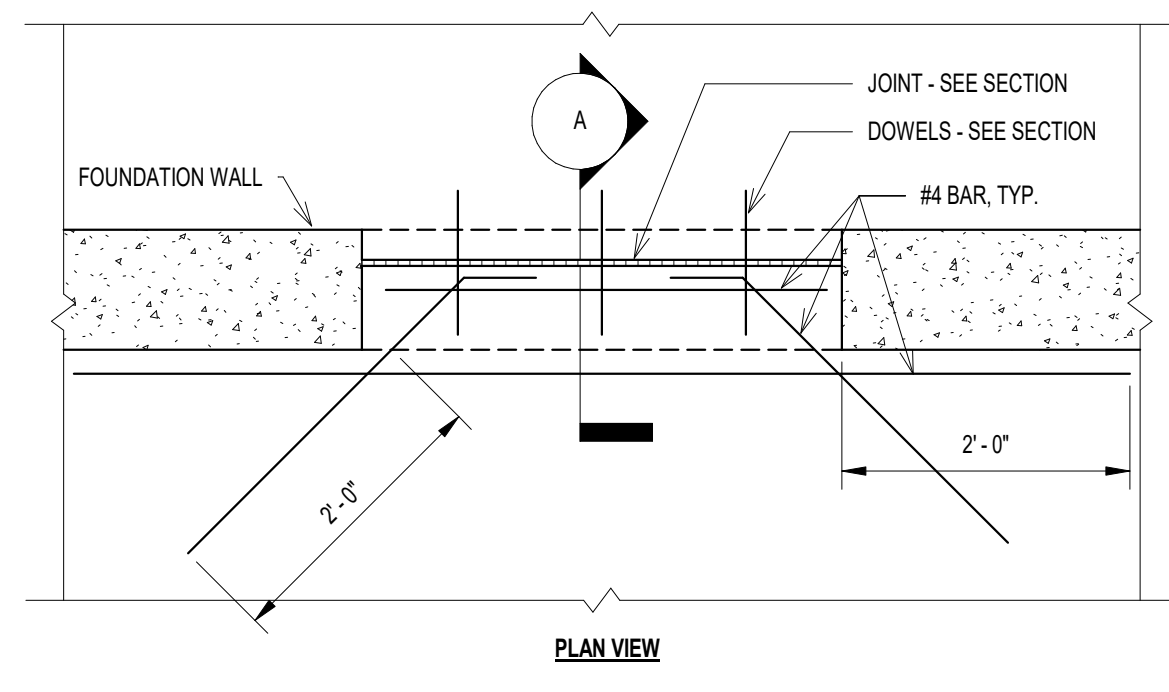

8 SOG AT EXTERIOR DOOR
3/4" = 1'-0"




ELEVATION

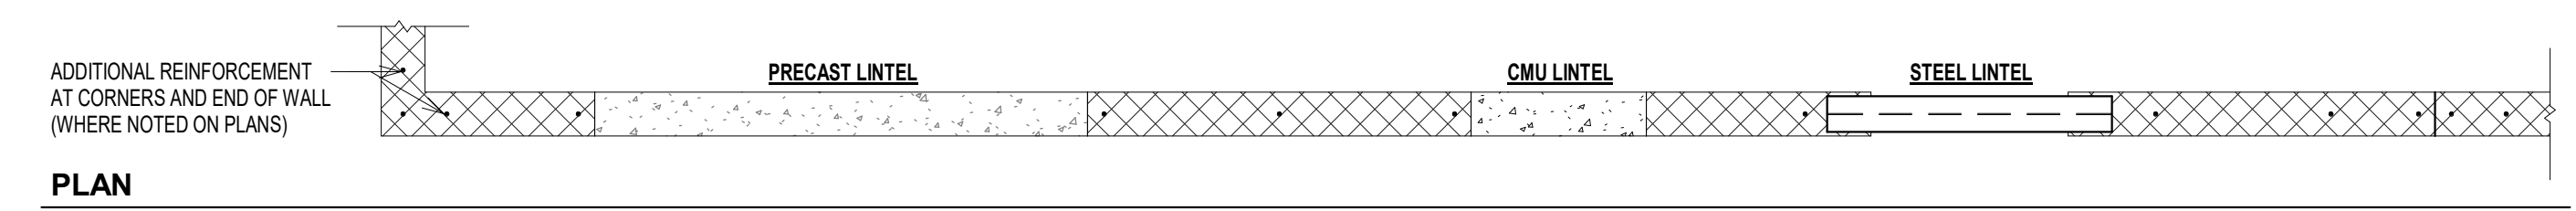



PLAN

- NOTES:
1. PROVIDE HORIZONTAL JOINT REINFORCING AT 8" O.C. IN FOUNDATION WALLS AND PARAPET WALLS. PROVIDE HORIZONTAL JOINT REINFORCING AT 16" O.C. IN ALL OTHER WALLS, U.N.O. SEE GENERAL NOTES FOR ADDITIONAL INFORMATION.
 2. GROUT CELLS AT REINFORCING ONLY, U.N.O. IN ARCH. DRAWINGS.
 3. GROUT CELLS OF MASONRY OPENINGS SOLID FOR FULL HEIGHT BENEATH LINTELS AND BEAMS.
 4. PROVIDE FOOTING DOWELS TO MATCH VERTICAL WALL REINF.
 5. WHERE NOT NOTED, PROVIDE 2#4 CONT. BOND BEAM REINF.
 6. WHERE REINF. IS NOT NOTED ON PLAN OR SECTION, REINF. PER THIS DETAIL.
 7. ALL CELLS WITH REINFORCING SHALL BE GROUTED SOLID. ALL CMU CELLS BELOW GRADE SHALL BE FULLY GROUTED.
 8. LAP BARS PER GENERAL NOTES.
 9. PROVIDE CONTROL JOINTS 2'-0" MINIMUM FROM WALL OPENINGS.

10 TYPICAL CMU WALL REINFORCING DETAILS
3/8" = 1'-0"

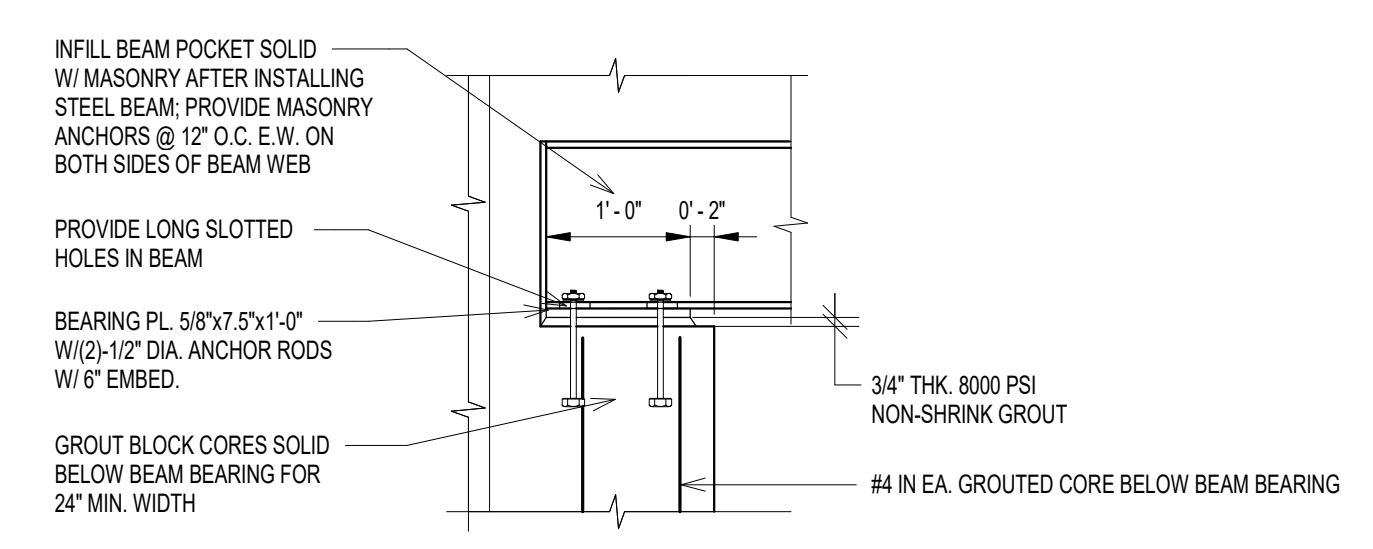


11 BEAM BEARING PARALLEL TO MASONRY WALL
3/4" = 1'-0"

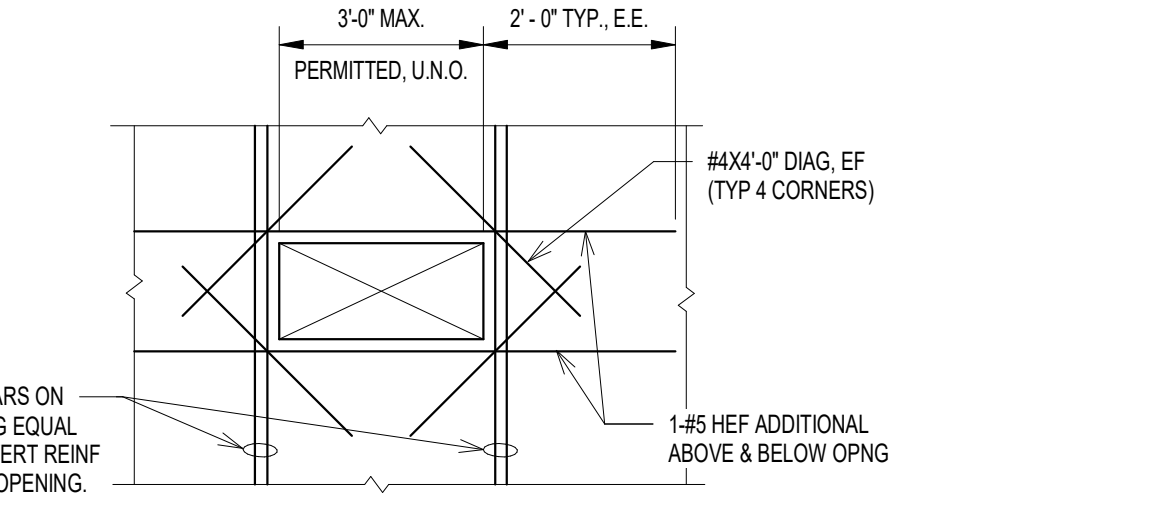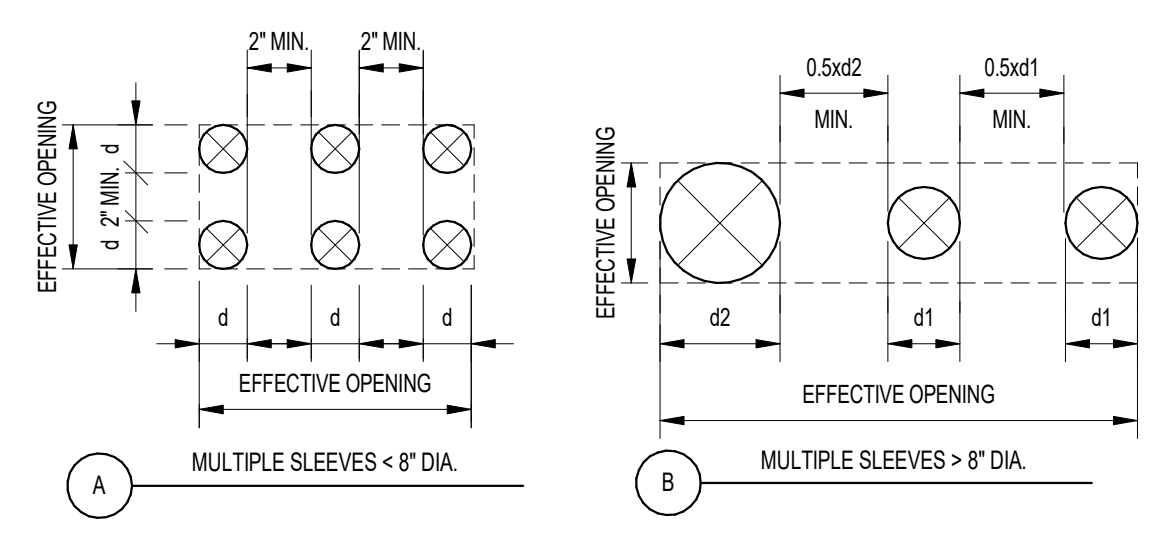


- NOTES:
1. OPENINGS SMALLER THEN 12"x12" REQUIRE NO ADDITIONAL REINFORCING STEEL.
 2. RECTANGULAR OPENING SHOWN, ADDITIONAL REINFORCING STEEL AROUND INDIVIDUAL ROUND OPENINGS > 12" DIAMETER SIMILAR.
 3. INDIVIDUAL PIPE SLEEVES < 12" DIAMETER REQUIRE NO ADDITIONAL REINFORCING.
 4. SPACE GROUPED SLEEVES PER DETAILS "A" AND "B" ABOVE AND TREAT AS A SINGLE EFFECTIVE RECTANGULAR OPENING. PROVIDE ADDITIONAL REINFORCING STEEL AROUND EFFECTIVE OPENING AS SHOWN ABOVE AND INSTALL REQUIRED HORIZONTAL AND VERTICAL REINFORCING STEEL UNINTERRUPTED BETWEEN SLEEVES.

6 OPENING IN CONCRETE WALL
1/2" = 1'-0"

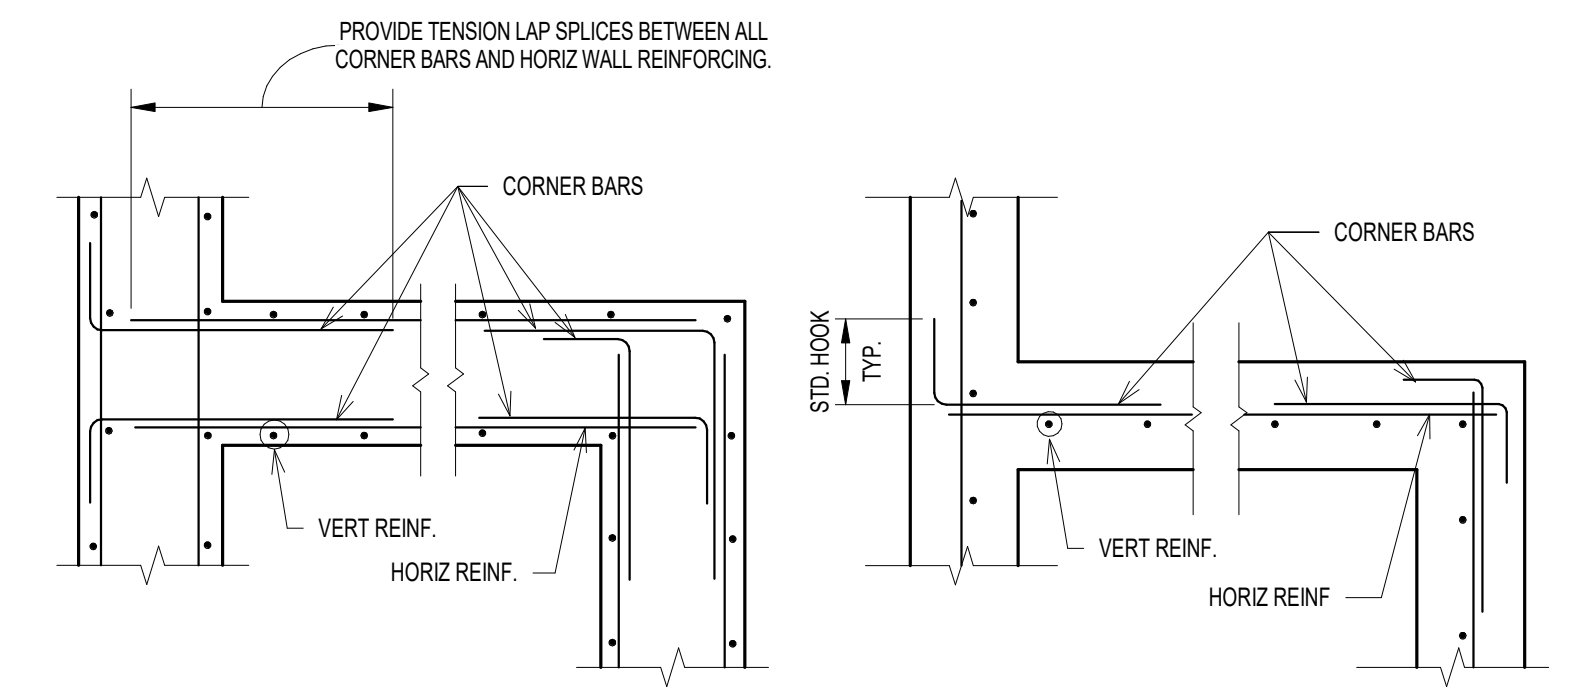


7 CORNER BAR REINFORCING FOR CONCRETE WALLS
1/2" = 1'-0"

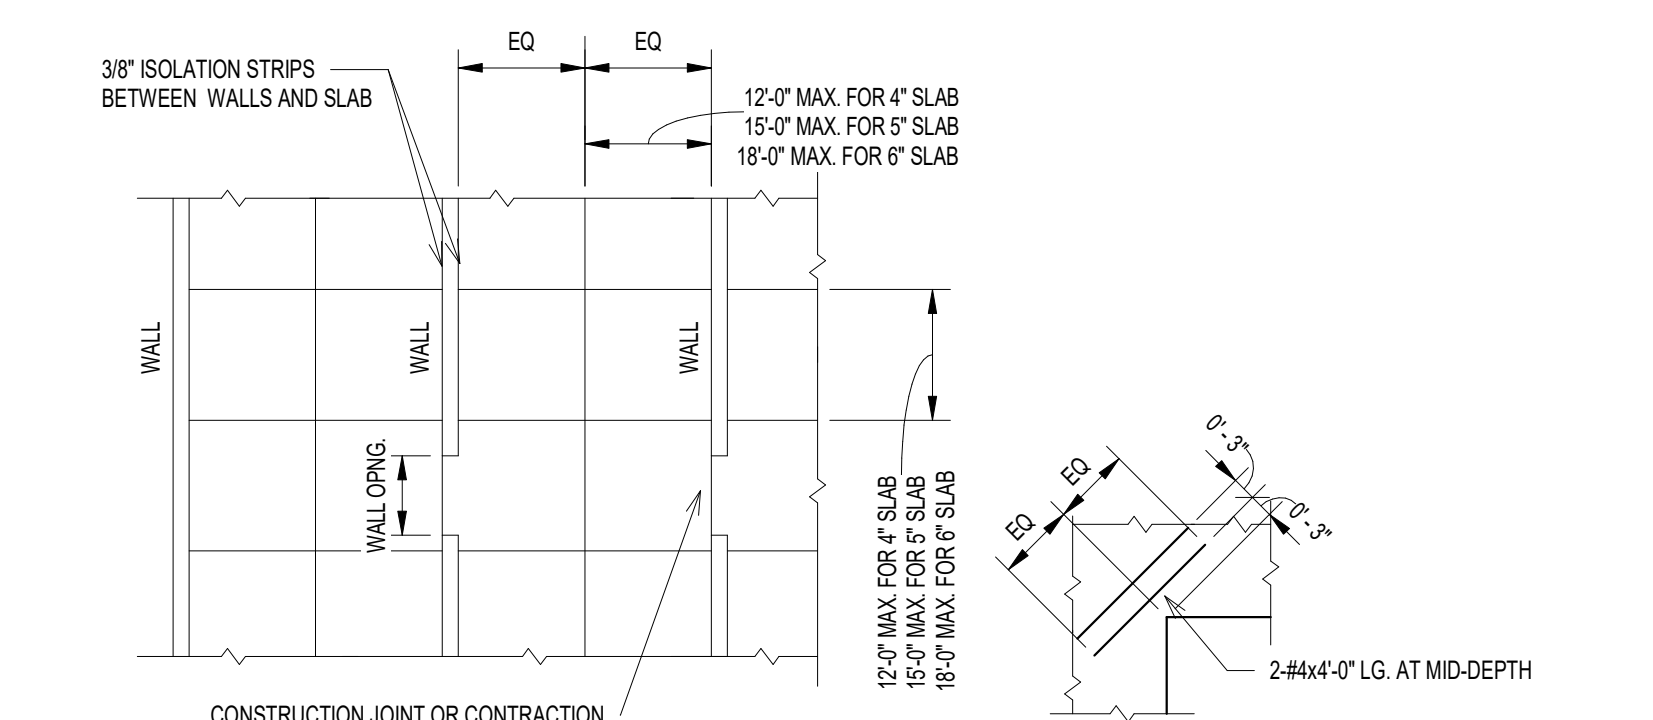


- NOTES:
1. LOCATE CONSTRUCTION JOINTS AND CONTRACTION JOINTS ON ALL COLUMN GRID LINES AND SUB-DIVIDE AS REQUIRED TO LIMIT MAXIMUM SPACING BETWEEN JOINTS TO MAXIMUM DIMENSIONS INDICATED ABOVE.
 2. LOCATE JOINTS IN A PATTERN THAT SUB-DIVIDES SLAB INTO PANELS THAT ARE SQUARE OR RECTANGULAR AND THAT HAVE AN ASPECT RATIO BETWEEN 1:1 (PREFERRED) TO 1:5.
 3. PROVIDE JOINTS AT ALL RE-ENTRANT CORNERS OR PROVIDE REINFORCING PER DETAIL "A" AT RE-ENTRANT CORNERS WHERE JOINTS CAN NOT OCCUR. PROVIDE REINFORCING PER DETAIL "B" AT DISCONTINUOUS JOINTS.
 4. PROVIDE SHOP DRAWING ILLUSTRATING JOINTS.


5 SLAB-ON-GRADE JOINT ARRANGEMENT BETWEEN BEARING WALLS
1/2" = 1'-0"

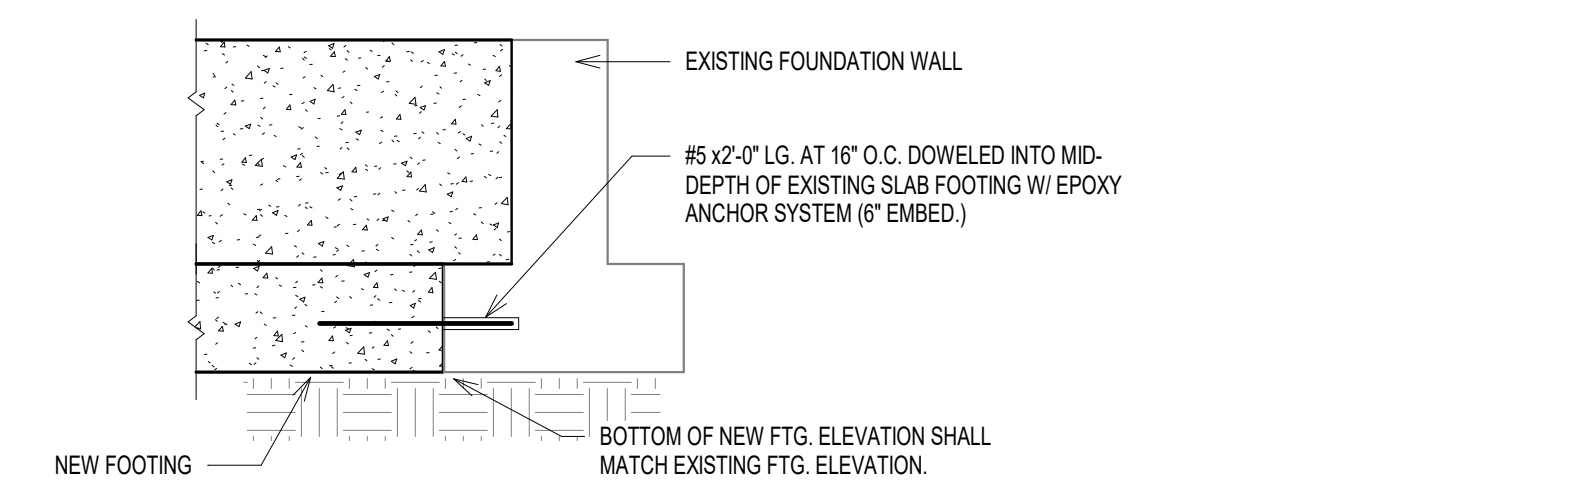


4 NEW FOUNDATION CONNECTION TO EXISTING FOUNDATION ON EXISTING SLAB-ON-GRADE
1/2" = 1'-0"

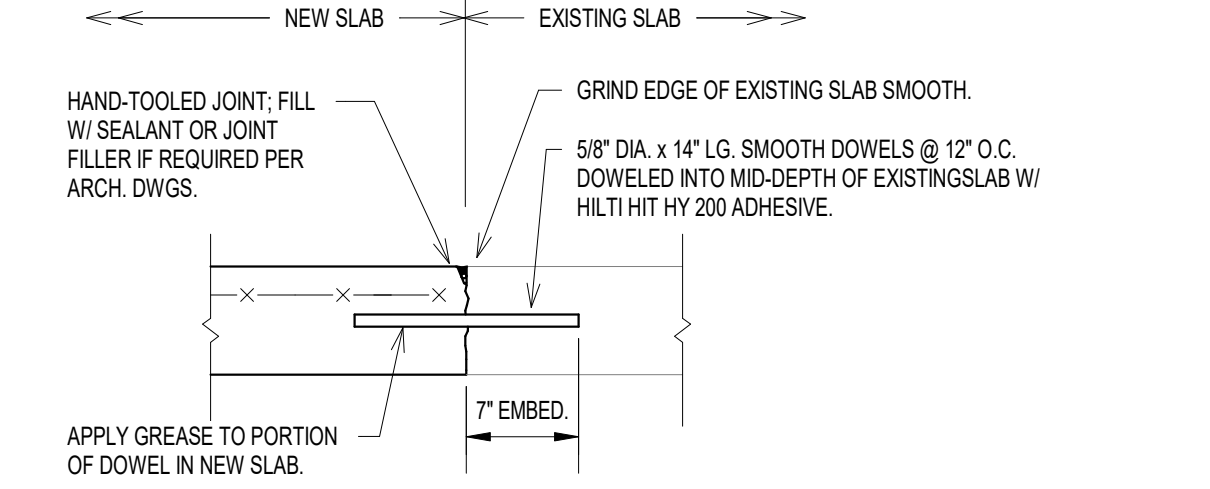

3 NEW SLAB-ON-GRADE CONNECTION TO EXISTING SLAB-ON-GRADE
1/2" = 1'-0"

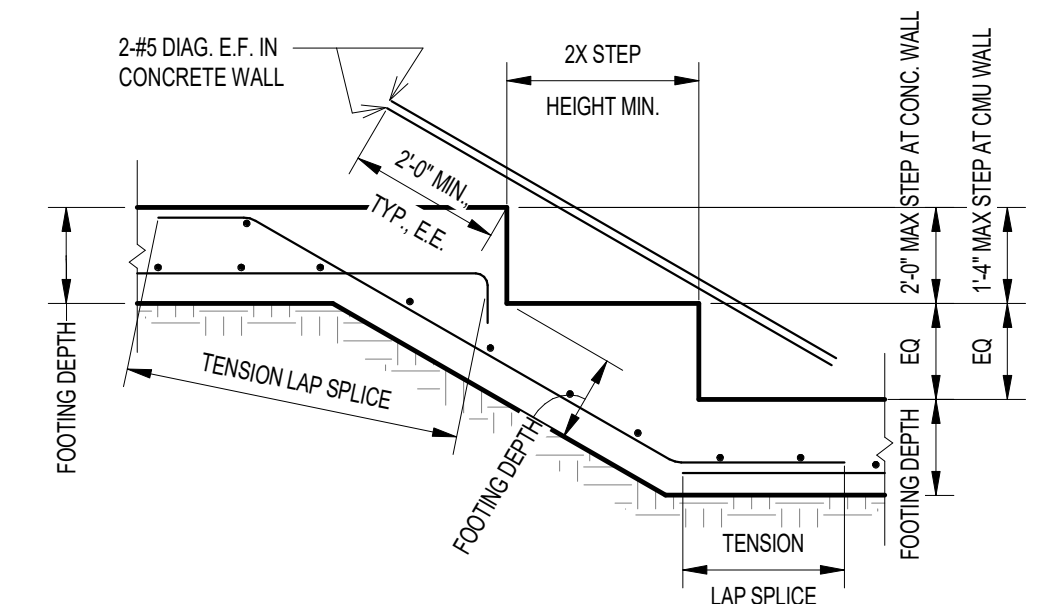

2 STEP IN WALL FOOTING
1/2" = 1'-0"

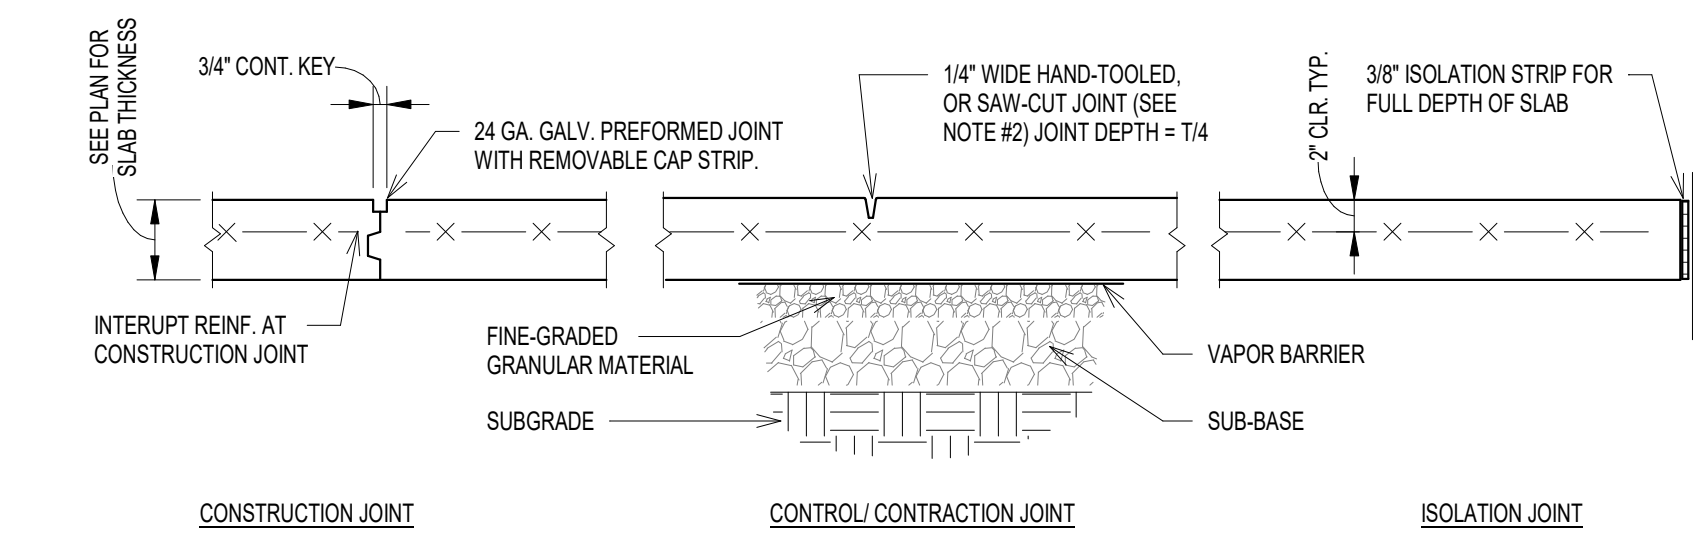

- NOTES:
1. CONTRACTION JOINTS SHALL BE INSTALLED EITHER BY HAND TOOLING, OR BY SAW-CUTTING USING A "SOFF-CUT" ULTRA EARLY ENTRY DRY-CUT SAW OR AN APPROVED EQUAL. JOINTS SHALL BE INSTALLED IMMEDIATELY WITHIN 12 HOURS OF POUR.
 2. REFER TO SPECIFICATIONS AND ARCHITECTURAL DRAWINGS FOR JOINT SEALANT REQUIREMENTS (IF ANY).
 3. REFER TO SPECIFICATIONS AND TO GEOTECHNICAL REPORT FOR REQUIREMENTS FOR SUBGRADE PREPARATION REQUIREMENTS.

1 SLAB ON GRADE CONSTRUCTION
1" = 1'-0"

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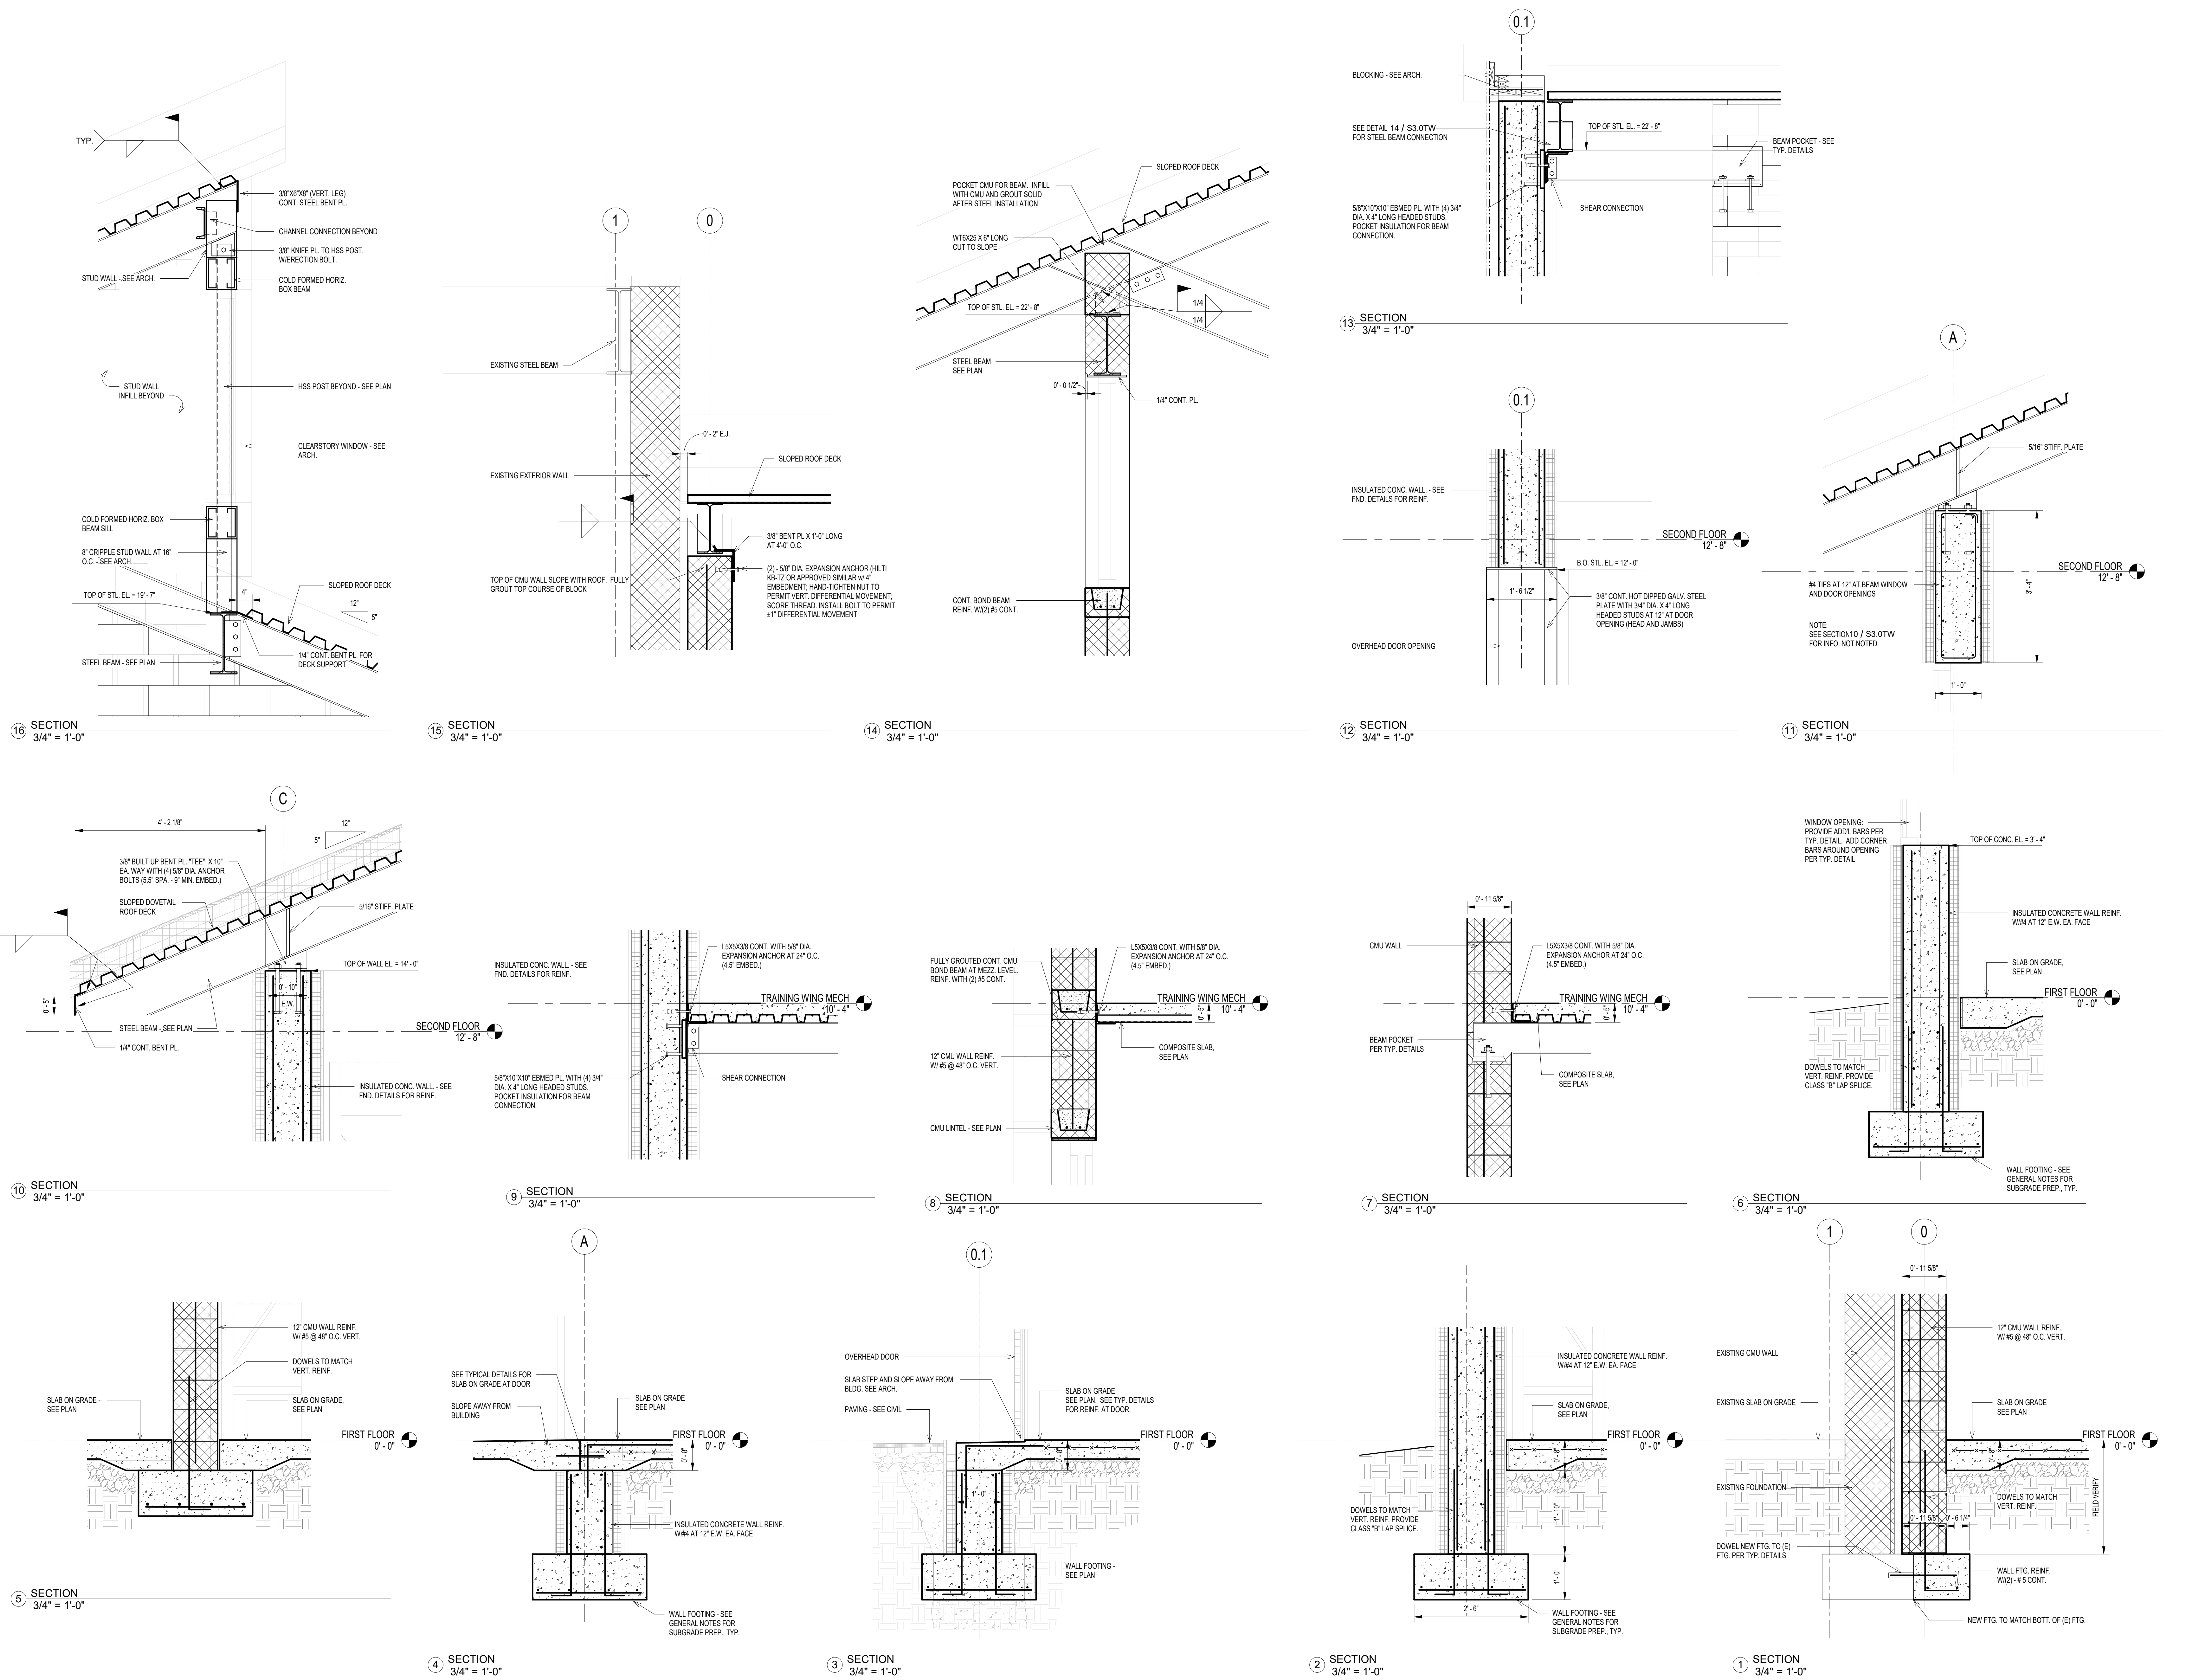
TRAINING WING ADDITION

Drawing Title:
TYPICAL DETAILS

Issue Date:
2022-12-16
Project Number:
0336.01
Drawing Number:

Drawn By:
NB

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ISSUE LOG

Distribution	Date	No.
ISSUE FOR PERMIT	12/16/22	

Client:
PA GAME COMMISSION

TRAINING WING ADDITION

Drawing Title:
SECTIONS

Issue Date:
2022-12-16
Project Number:
0336.01
Drawing Number:

Drawn By:
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